

Development Tribunal – Decision Notice

Planning Act 2016, section 255

Appeal Number: 27 - 18

Appellant: Scott Doohan, Scott Doohan Developments.

Assessment Manager: Steve Morley, Total Building Consult.

Concurrence Agency: The Council of the City of Gold Coast.

(if applicable)

Site Address: 138 Jefferson Lane, Palm Beach and described as Lot 0 on BUP 11547 —

the subject s

Appeal

Appeal under section 229 and Schedule 1, section 1, Table 1, Item 1 of the Planning Act 2016 against the decision of the Assessment Manager, to refuse a development permit for building work for a Class 10a carport. The Council of the City of Gold Coast as the Concurrence Agency directed the Assessment Manager to refuse the application on the basis that the development conflicted with, and did not comply with, Performance Outcome P01 'Setbacks' of the Medium density residential zone of Section 6.2.2 of the City of Gold Coast City Plan Version 6.

Date and time of hearing: 10.00am on Wednesday 3 October 2018.

Place of hearing: Gold Coast City Council offices, Waterside East E2.2, 9 Holden Place

Bundall.

Tribunal: Don Grehan – Chair

Murray Lane - Member

Present: Scott Doohan, Scott Doohan Developments – Appellant

Steve Morley, Total Building Consult – Appellant's representative

Reza luchanet - Council representative Wiremu Cherrington - Council representative

Peter Krook - Council representative

Decision:

The Development Tribunal (Tribunal), in accordance with section 254(2)(c) of the PA **replaces** the decision of Council to refuse the development application for building works to construct a Class 10a Carport, with a decision to allow the development application with siting and design of the structures as proposed in Architectural and Engineering plans marked 'Development Tribunal Appeal 27-18 Referenced Plans', Pages 1 to 8 attached to and forming part of this decision.

Background

- The Assessment Manager refused a development permit for building work in relation to a
 proposed Class 10a carport the siting of which was contrary to the road boundary setbacks
 identified as Acceptable Outcomes in the Medium Density Residential Zone Code of City
 of Gold Coast City Plan, Version 6, as the relevant assessment benchmark.
- 2. The Council, directing the refusal, considered that development conflicted with, and did not comply with, Performance Outcome P01 of the Medium Density Residential Zone Code of the City of Gold Coast City Plan Version 6 in that:
 - (a) the proposed development has not been designed cognisant of a 1.5 metre wide setback area measured from the front property boundary for the purpose of future road widening as applied by Council for other developments in Jefferson Lane. Such future road widening was requested by Council as Referral Agency in its Information Request dated 28 May 2018 and has not been incorporated into the submitted design;
 - (b) the proposed development is considered potentially detrimental to the streetscape character of Jefferson Lane being a narrow road reserve containing substantial multilevel development. The specific width and height of the proposal is considered undesirable in terms of preferred open carport width and otherwise contributes to an undesirable level of amenity when viewed from that roadway.
- 3. The Appellant, dissatisfied with the refusal, lodged an appeal with the Development Tribunal Registry against the Decision of the Assessment Manager.

Jurisdiction

4. Appeal made under the Planning Act 2016 (PA), section 229(1)(a)(i) and Schedule 1, section 1(2)(g) and Table 1, item 1(a) being an appeal by the Appellant (the Appellant) against the refusal of all or part of the development application by the Assessment manager (The Respondent) and the Concurrence Agency (The Co-respondent).

Decision framework

- 5. Section 253 of the PA sets out matters relevant to the conduct of this appeal with subsections 253(2), 253(4) and 253(5) confirming specific aspects.
- 6. Section 253(2) of the PA confirms that generally, the appellant must establish the appeal should be upheld.
- 7. Section 253(4) of the PA confirms that the tribunal must hear and decide the appeal by way of a reconsideration of the evidence that was before the person who made the decision appealed against.
- 8. Section 253(5) of the PA however confirms that the tribunal may, but need not, consider-
 - (a) other evidence presented by a party to the appeal with leave of the tribunal; or
 - (b) any information provided under section 246.
- Section 246 of the PA provides that the Registrar may, at any time, ask a person to give the registrar any information that the registrar reasonably requires for the proceedings; and
- 10. Section 254 of the PA deals with how this appeal may be decided and the first three subsections of that section are as follows:

- (1) This section applies to an appeal to a tribunal against a decision.
- (2) The tribunal must decide the appeal by -
 - (a) confirming the decision; or
 - (b) changing the decision; or
 - (c) replacing the decision with another decision; or
 - (d) setting the decision aside, and ordering the person who made the decision to remake the decision by a stated time; or
 - (e) for a deemed refusal of an application-
 - (i) ordering the entity responsible for deciding the application by a stated time and, if the entity does not comply with the order, deciding the application; or
 - (ii) deciding the application.
- (3) However, the tribunal must not make a change, other than a minor change, to a development application.
- 11. Section 254(3) uses the expression 'minor change' and that expression is defined relevantly in Schedule 2 of the PA as follows:

minor change means a change that-

- (a) for a development application—
 - (i) does not result in substantially different development; and
 - (ii) if the application, including the change, were made when the change is made—would not cause—
 - (A) the inclusion of prohibited development in the application; or
 - (B) referral to a referral agency if there were no referral agencies for the development application; or
 - (C) referral to extra referral agencies; or
 - (D) a referral agency to assess the application against, or have regard to, matters prescribed by regulation under section 55(2), other than matters the referral agency must have assessed the application against, or have had regard to, when the application was made; or
 - (E) public notification if public notification was required for the development application;
- 12. Schedule 1 of the Development Assessment Rules (DARs) refers to the 'minor change' aspect as follows:
 - (a) An assessment manager or responsible entity may determine that the change is a minor change to a development application or development approval, where amongst other criteria a minor change is a change that would not result in 'substantially different development'.
 - (b) An Assessment Manager or responsible entity must determine if the proposed change would result in substantially different development for a change
 - (a) made to a proposed development application the subject of a response given under section 57(3) of the Act and a properly made application;
 - (b) made to a development application in accordance with Part 6;
 - (c) made to a development approval after the appeal period.
- 13. In determining whether the proposed change would result in a substantially different development, the assessment manager or referral agency must consider the individual circumstances of the development, in the context of the change proposed (DARs schedule 1).

- 14. Under the DARs, schedule 1, a change may be considered to result in a substantially different development if any of the following apply to the proposed change:
 - (a) involves a new use; or
 - (b) results in the application applying to a new parcel of land; or
 - (c) dramatically changes the built form in terms of scale, bulk and appearance; or
 - (d) changes the ability of the proposed development to operate as intended: or
 - (e) removes a component that is integral to the operation of the development; or
 - (f) significantly impacts on traffic flow and the transport network, such as increasing traffic to the site; or
 - (g) introduces new impacts or increase the severity of known impacts; or
 - (h) removes an incentive or offset component that would have balanced a negative impact of the development; or
 - (i) impacts on infrastructure provisions.

Amended Drawings

15. Following discussions at the hearing, amended architectural and engineering drawings to better address streetscape character and other specific concerns regarding future development within the vicinity if the subject were submitted to the Tribunal by the appellant and these drawings were then distributed to all parties via the Registrar.

Material Considered

The material considered in arriving at this decision comprises:

- 16. 'Form 10 Appeal Notice', grounds for appeal and correspondence accompanying the appeal lodged with the Tribunals Registrar on the 4th of July 2018.
- 17. Plans and Specification for the proposed carport as submitted to the Assessment Manager.
- 18. Council of the City of Gold Coast referral response as the Concurrence Agency dated the 19th of June 2018, Reference Number PN91952/04/02 BLD201805424.
- 19. Development Application Decision Notice Refusal Reference Number 00009889 from Assessment Manager, dated the 20th of June 2018.
- 20. The Planning Act Planning Act 2016.
- 21. The Building Act 1975.
- 22. The Building Regulation 2006.
- 23. The Gold Coast City Plan, Version 6.
- 24. Verbal submissions from the Appellant. at the hearing.
- 25. Verbal submissions from Council representatives at the hearing.
- 26. Amended Plans for the proposed works as submitted by the Appellant (allowed into evidence with the tribunal's leave).

Findings of Fact

26. The subject site is a 405m² non-uniform rectangular shaped allotment situated to western side the west Jefferson Lane, in an established residential area of Palm Beach.

- 27. An existing four storey duplex is located on the subject site.
- 28. The Appellant proposes to construct a 10m wide x 6.1m deep carport which would result in zero setback from Jefferson Lane which would be contrary to the road boundary setbacks identified as Acceptable Outcomes in the Medium Density Residential Zone Code of City of Gold Coast City Plan, Version 6, as the relevant assessment benchmark.
- 29. The subject site is zoned Medium Density Residential under the *Gold Coast City Plan* is *Version 6*.
- 30. Relevant to the subject building development application, the City of Gold Coast's jurisdiction is limited to its Referral Agency functions under Section 33 of the *Building Act* 1975 in relation to assessing whether the proposed building or structure complies with the quantifiable standards under the *Gold Coast City Plan* in respect of boundary clearances.
- 31. The *Building Regulation 2006* in Part 3, nominates the Queensland Development Code, as setting out the standard siting requirements for buildings and structures, except where the *Gold Coast City Plan* identifies an alternative siting provision.
- 32. The applicable version of the *Gold Coast City Plan* is *Version 6*, which became effective on 3 July 2017. Part 1.5 of the *Gold Coast City Plan Version 6* details the relationship between the *Building Act 1975* and the *Queensland Development Code*. In particular, 'Table 1.5-1: Building assessment provisions' details the relevant codes for proposed alternatives to the *Queensland Development Code*'s boundary clearance provisions:
- 33. The *Gold Coast City Plan Version 6* identifies the subject site as being in the Medium Density Residential Zone and subject to the Coastal Erosion Hazard Overlay Foreshore Seawall (Foreshore seawall setback).
- 34. According to Table 1.5-1: Building assessment provisions of the Gold Coast City Plan Version 6 the relevant codes are:
 - (i) Medium Density Residential Zone Code
 - (ii) Coastal Erosion Hazard Overlay Code

Noting that in the event of an inconsistency between the zone code and the overlay code, the overlay code prevails.

- 35. The relevant assessment provisions to assess alternative 'boundary clearance provisions' are set out in the Medium Density Residential Zone Code of the *Gold Coast City Plan Version 6* and are limited to PO1 and AO1.
- 36. It is evident in the application material that the Coastal Erosion Hazard Overlay Code was addressed by the assessment manager to the satisfaction of the referral agency, and that the building development application complies with this code.
- 37. Performance Outcome P01 'Setbacks' of the Medium density residential zone of Section 6.2.2 of the City Plan requires that setbacks:
 - (a) assist in the protection of adjacent amenity;
 - (b) allow for access around the building;
 - (c) contribute to the streetscape character; and
 - (d) allow for on-site car parking.
- 38. The relevant performance Outcomes do not include provision for the consideration of future road widening.

39. A number of building and structures of similar size and dimension, being Class 10a non-habitable private garages, carports, sheds, or the like are situated in Jefferson Lane and share similar reduced road boundary setbacks to that proposed on the subject site.

Reasons for the Decision

40. The tribunal, having considered the extent and nature of the revised design illustrated in the amended drawings, is satisfied that they reflected only a 'minor change' to the original proposal (in terms of section 254(3) of the PA) for the following reasons:

The amended proposal will not result in a substantially different development as it will not:

- (a) involve a new use as the use remains the same;
- (b) result in the application applying to a new parcel of land;
- (c) dramatically change the built form in terms of scale, bulk and appearance;
- (d) change the ability of the proposed development to operate as intended; or
- (e) remove a component that is integral to the operation of the development.
- 41. The tribunal, having considered the revised design illustrated in the amended drawings, and the streetscape in the vicinity of the subject site, is satisfied that the proposed carport meets Performance Outcome PO1 of the Medium Density Residential Zone Code of City of Gold Coast City Plan Version 6 in so far that:
 - the benign nature of its use has no effect in relation to the amenity of adjoining properties;
 - (ii) its proposed location does not prohibit or limit access around the building;
 - (iii) its design contributes to the streetscape character as equally as other similarly sited carports and garages in the direct vicinity; and
 - (iv) it provides adequately for on-site car parking.

Don Grehan Development Tribunal Chair

Date: 12 March 2019

Appeal Rights

Schedule 1, Table 2 (1) of the *Planning Act 2016* provides that an appeal may be made against a decision of a Tribunal to the Planning and Environment Court, other than a decision under section 252, on the ground of -

- (a) an error or mistake in law on the part of the Tribunal; or
- (b) jurisdictional error.

The appeal must be started within 20 business days after the day notice of the Tribunal decision is given to the party.

The following link outlines the steps required to lodge an appeal with the Court. http://www.courts.qld.gov.au/courts/planning-and-environment-court/going-to-planning-and-environment-court/starting-proceedings-in-the-court

Enquiries

All correspondence should be addressed to:

The Registrar of Development Tribunals Department of Housing and Public Works GPO Box 2457 Brisbane QLD 4001


Telephone (07) 1800 804 833 Facsimile (07) 3237 1248

Email: registrar@hpw.qld.gov.au

CARPORT ADDITION

SUBMISSION SET 138 JEFFERSON LANE, PALM BEACH



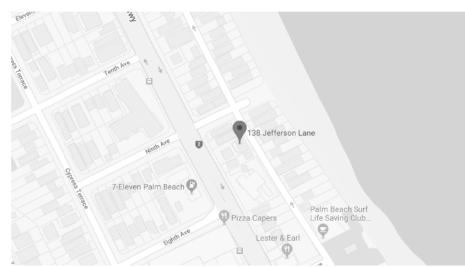

DRAWINGS		
#	NAME	rev.
1	COVER PAGE	Е
2	SITE PLAN	Е
3	GROUND FLOOR PLAN	Е
4	ELEVATIONS	Е
5	ELEVATIONS	Е



Revis	Revisions:		
Α	CONCEPT PLANS	14.01.2018	
В	SUBMISSION SET	06.02.2018	
E	ROOF AMENDMENT	06.10.2018	

ALL CONSTRUCTION WORKS TO BE IN ACCORDANCE WITH RELEVANT AUSTRALIAN STANDARDS & BCA.

FIGURED DIMENSIONS TO BE TAKEN IN PREFERENCE TO SCALING.

THESE PLANS ARE TO BE READ IN CONJUNCTION WITH THE BASIX CERTIFICATE REPORT AND ITS REQUIREMENTS.

THE DEVELOPMENT IS TO MAINTAIN EROSION SEDIMENTATION CONTROL.

LANDSCAPING TO BE IN ACCORDANCE WITH BASIX REQUIREMENTS.

Client Name

JEFFERSON RESIDENCE

Client Address

138 JEFFERSON LANE PALM BEACH

LOT / RP:

0 / 11547

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Project Name : A L T S & A D D I T I O N S

Drawing Title: COVER PAGE

Drawn

tus: CONCEPT

Scale

evision:


wing No.:

137m² 0:33 : 1 (33.8%)

200m²

205m²

50.6%

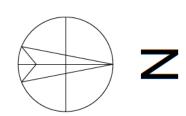

TOTAL FLOOR AREA

FLOOR SPACE RATIO (FSR) TOTAL HARD SURFACES

TOTAL LANDSCAPED AREA

LANDSCAPED OPEN SPACE


← NE= SUMMER SEA BREEZE

= Proposed
= Existing
= To owner

= To owner

= Landscape Open Space = Hard Surfaces

= Boundary Setbacks

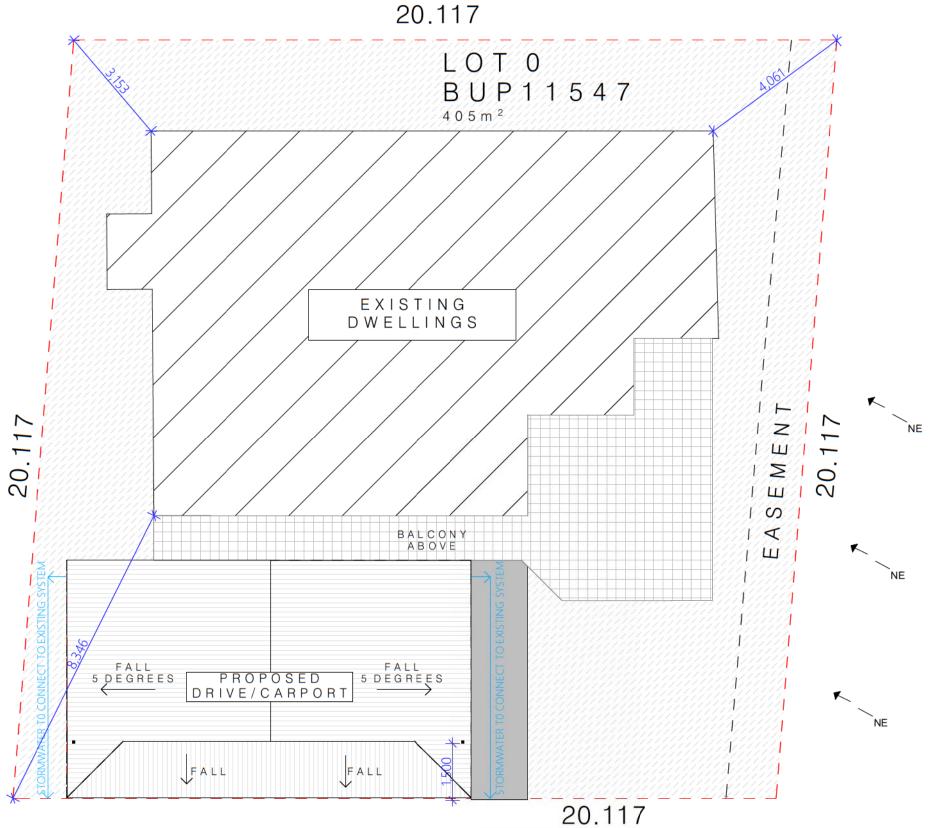



ions :	
CONCEPT PLANS	14.01.2018
SUBMISSION SET	06.02.2018
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	CONCEPT PLANS SUBMISSION SET

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Project Name: ALTS & ADDITIONS

Drawing Title: SITE PLAN

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tus: CONCEPT


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Revision:

rawing No.:

JEFFERSON LANE

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Γ	Revisions :		
	Α	CONCEPT PLANS	14.01.2018
	В	SUBMISSION SET	06.02.2018
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LANDSCAPING TO BE IN ACCORDANCE WITH BASIX REQUIREMENTS.

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Client Address

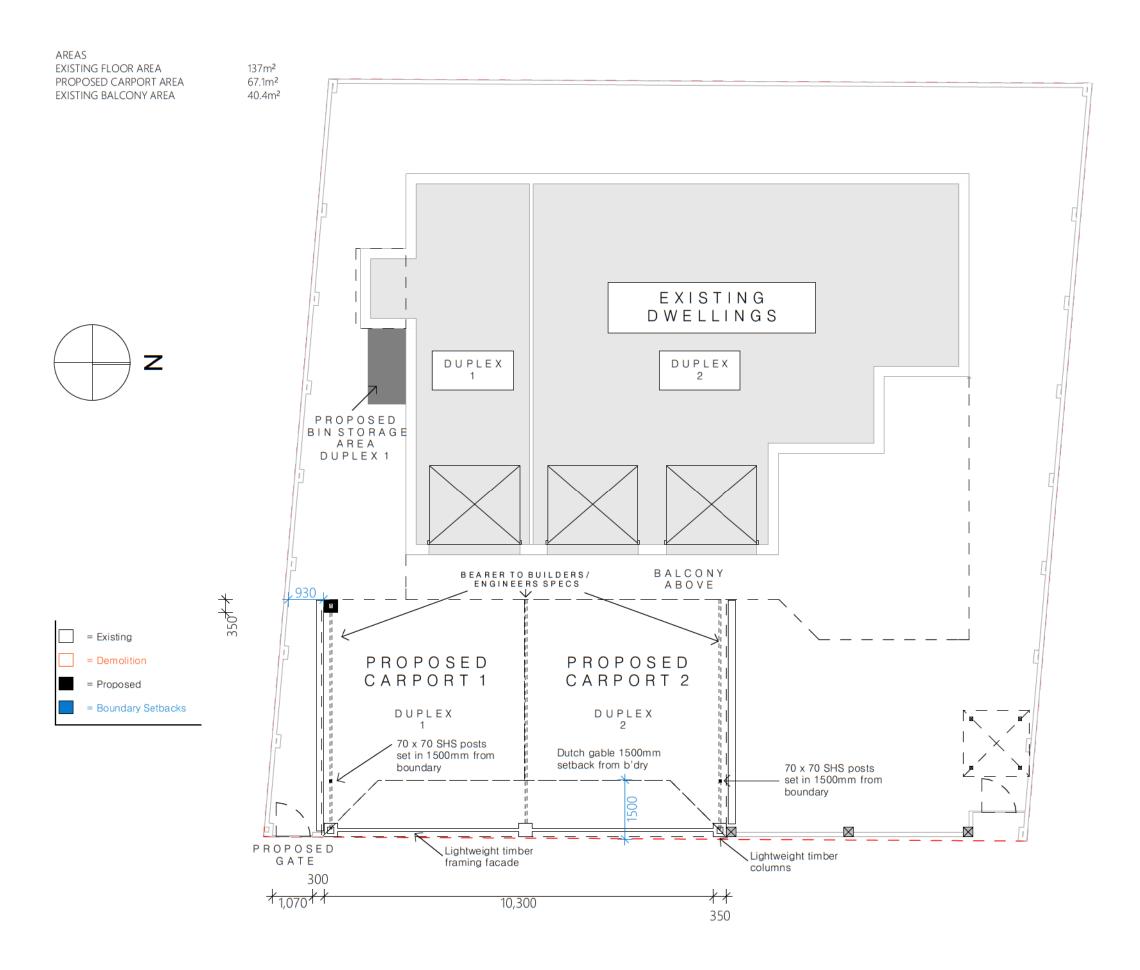138 JEFFERSON LANE PALM BEACH

LOT / RP:

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Project Name: ALTS & ADDITIONS

Drawing Title: GROUND FLOOR PLAN

CONCEPT

1:100

Drawing No. :

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Development Tribunal Appeal 28-18 Referenced Plans, Page 4 of 8.



EAST ELEVATION 1:100



Revis	ions :	
Α	CONCEPT PLANS	14.01.2018
В	SUBMISSION SET	06.02.2018
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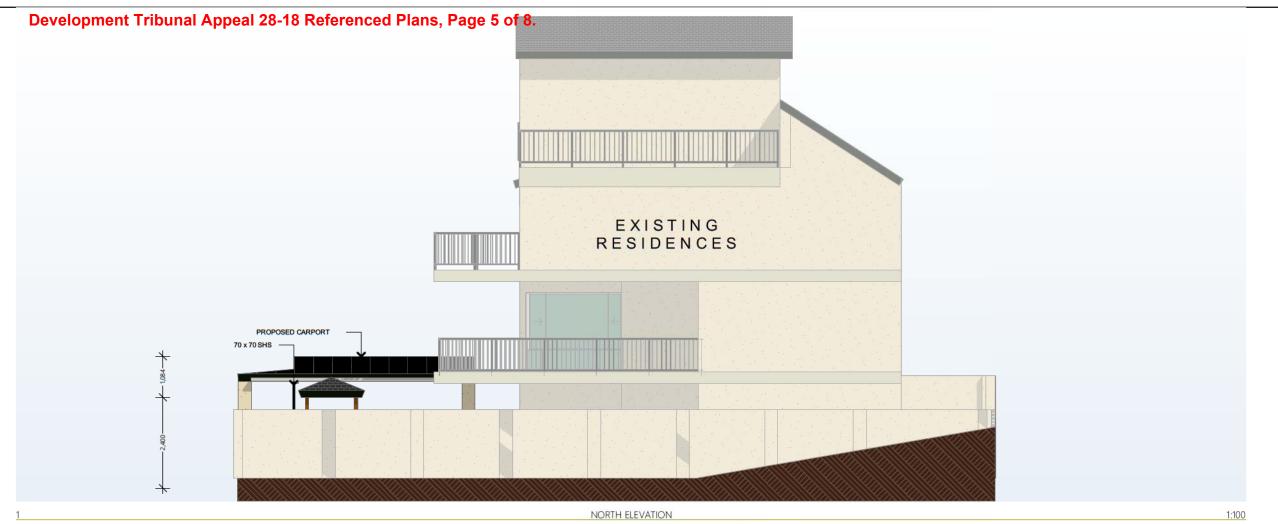
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Project Name: ALTS & ADDITIONS

Drawing Title: ELEVATIONS

CONCEPT 1:100





SOUTH ELEVATION



Ì	Revis	ions :	
	Α	CONCEPT PLANS	14.01.2018
	В	SUBMISSION SET	06.02.2018
	E	ROOF AMENDMENT	06.10.2018

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Client Name

JEFFERSON RESIDENCE

Client Address

138 JEFFERSON LANE PALM BEACH

0 / 11547


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Drawing Title: ELEVATIONS

1:100

CONCEPT 1:100



STRUCTURAL STEELWORK

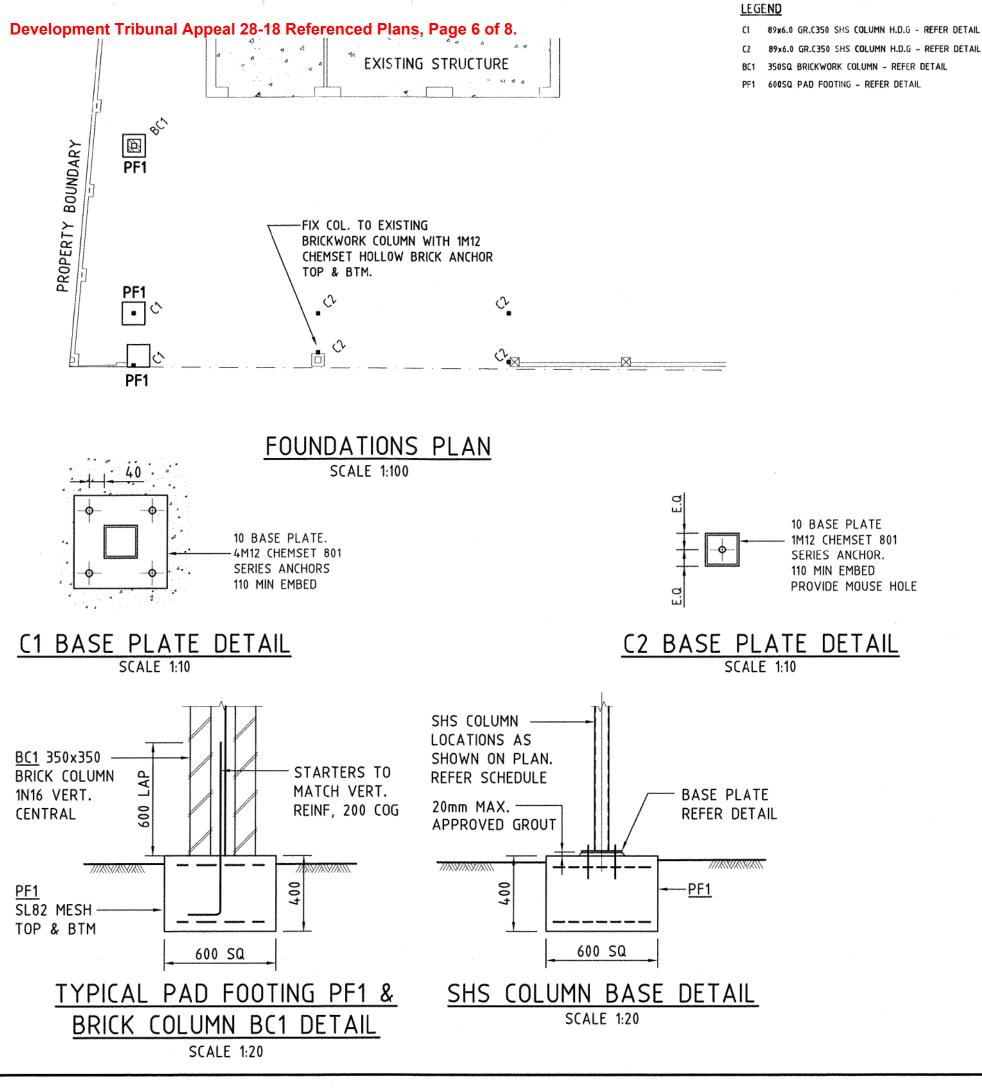- 1. FABRICATE AND ERECT ALL STRUCTURAL STEELWORK IN ACCORDANCE WITH AS 1554, AS 4100 AND AS 1252.
 - 2. VERIFY ALL SETTING OUT DIMENSIONS FROM THE ARCHITECTURAL DRAWINGS.
 - 3. DO NOT OBTAIN DIMENSIONS BY SCALING THE STRUCTURAL ELEMENTS.
 - 4. UNLESS OTHERWISE NOTED USE 10 mm THICK GUSSET, FIN AND END PLATES. M16 8.8 / TF BOLTS , ALL HOT DIP GALV. BOLTS SO MARKED MAY BE 8.8/s 6mm CONTINUOUS FILLET WELD MADE WITH E 48 xx MILD STEEL ELECTRODES.
 - 5. CPBW DENOTES COMPLETE PENETRATING BUTT CFW DENOTES CONTINUOUS FILLET WELD ALL WELDS CATEGORY STRUCTURAL PURPOSE (SP) UNLESS NOTED OTHERWISE.
 - 6. PROVIDE TEMPORARY BRACING AS TO STABILISE THE STRUCTURE.
- 7. CORROSION PROTECTION AND SURFACE FINISH IS TO BE AS AGREED WITH OWNER.
- TOUCH UP AFTER ERECTION TYPICAL.
- 8. IF IN DOUBT ASK.
- 9. ALL EXPOSED STEELWORK TO BE HOT DIP GLAV

<u>BRICKWORK</u>

- 1. PROVIDE BRICK TIES IN ACCORDANCE WITH THE REQUIREMENTS OF AS 3700 THE SAA MASONRY CODE. CORROSION RESISTANCE RATING FOR TIES
- 2. PROVIDE ADDITIONAL TIES AT SLAB LEVEL TO RESIST LOADING FOR TC3 WIND CONDITIONS 49 m/sec. BASIC DESIGN VELOCITY, NON - CYCLONIC.
- 3. MINIMUM COMPRESSIVE STRENGTH OF BRICKS (F'm) TO BE NOT LESS THAN 20 MPa.
- 4. PROPORTIONS OF MORTAR ARE TO BE SUCH THAT THE MORTAR STRENGTH IS EQUIVALENT TO OR BETTER THAN A 1:1:6 CEMENT - LIME - SAND MIX. MINIMUM CUBE STRENGTH TO BE 2.8 MPa.
- 5. PROVIDE SLIP JOINTS AND CONTROL JOINTS AT ENDS OF CONCRETE MEMBERS AS DETAILED.
- 6. DO NOT BUILD ANY BRICKWORK ON SLABS UNTIL PROPS ARE REMOVED OR PROVIDE JOINTS IN WALLS TO CATER FOR SLAB DEFLECTION.
- 7. ALL WORK TO BE IN ACCORDANCE WITH THE FOLLOWING AND OTHER RELEVANT CODES -

AS 3700 - SSA MASONRY CODE AS 1225 - CLAY BUILDING BRICKS.

AS 1226 - METHODS OF SAMPLING AND TESTING CLAY BRICKS

AS 1653 - CALCIUM SILICATE BRICKS.

AS 2701 - MORTAR FOR MASONRY CONSTRUCTION.

8. PROVIDE FULL HEIGHT MASONRY ARTICULATION IN ACCORDANCE WITH THE CEMENT AND CONCRETE ASSOCIATIONS TECHNICAL NOTE NO. 61 "ARTICULATED

FOOTING DESIGN

FOOTING DESIGN TO FOUND INTO SOUND NATURAL MATERIAL HAVING A MINIMUM ALLOWABLE BEARING PRESSURE OF 100KPa. CONFIRM ON SITE.

DESIGN LOADS

WIND - N3 ROOF L.L

- 0.25 kPa

GENERAL 1. CARRY OUT ALL WORK IN ACCORDANCE WITH THE REQUIREMENTS OF THE RELEVANT SAA CODES.


- 2. VERIFY ALL SETTING OUT DIMENSIONS WITH THE
- ARCHITECT OR DESIGNER. 3. DO NOT OBTAIN DIMENSIONS BY SCALING THE
- STRUCTURAL ELEMENTS. 4. IN CASE OF DOUBT - ASK.

CONCRETE

- 1. ALL CONCRETE WORK IS TO BE IN ACCORDANCE WITH THE REQUIREMENTS OF AS 3600.
- 2. PARTICULAR ATTENTION IS TO BE PAID TO THE CURING OF EXPOSED CONCRETE.
- 3. ALL CONCRETE IS TO BE VIBRATED.
- 4. SAMPLE AND TEST CONCRETE IN ACCORDANCE
- WITH AS 3600. 5. CONCRETE STRENGTHS TO BE AS LISTED BELOW: - 20MPa
- 6. SLUMP 70mm MAX. AGGREGATE 20 mm.

REINFORCEMENT

- 1. FIX REINFORCEMENT AS SHOWN ON DRAWINGS. THE TYPE AND GRADE ARE INDICATED BY SYMBOLS SHOW BELOW FOLLOWED BY A NUMBER DENOTING THE BAR DIAMETER IN mm -
- N DENOTES 500N BAR TO AS4671
- S DENOTES STRUCTURAL GRADE DEFORMED BAR
- R DENOTES STRUCTURAL GRADE PLAIN ROUND BAR SL - DENOTES HARD DRAWN WIRE FABRIC.
- 2. LAPS IN REINFORCEMENT TO BE FULL TENSION LAPS EXCEPT AS OTHERWISE NOTED.
- 3. REINFORCEMENT TO BE ADEQUATELY CHAIRED TO MAINTAIN SPECIFIED COVERS - MAXIMUM CHAIR SPACING TO BE 800mm. PROVIDE ADDITIONAL SUPPORT BARS IF NECESSARY TO MAINTAIN COVERS.
- 4. SUPPORT BARROW RUNS AND PUMP LINES CLEAR OF REINFORCEMENT
- 5. UNLESS NOTED OTHERWISE ON DRAWINGS, CONCRETE COVER TO REINFORCEMENT TO BE AS LISTED BELOW: - 50 MIN. ALL AROUND

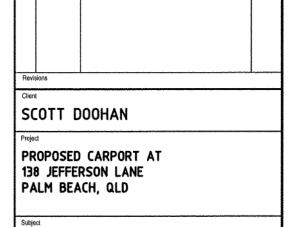

LAURIE OAR

LAURIE OAR & ASSOCIATES PTY, LTD. CONSULTING CIVIL & STRUCTURAL ENGINEERS


FOUNDATIONS PLAN & DETAILS

22 MARTIN STREET NERANG QLD 4211 I.oar@bigpond.com

A.B.N. 19 198 205 906 PH. (07) 5527 2288 FAX. (07) 5527 3388


OCT. '18 K.K L.0. 18-548 01 SCALES. AS SHOWN AT A3


Development Tribunal Appeal 28-18 Referenced Plans, Page 7 of 8.

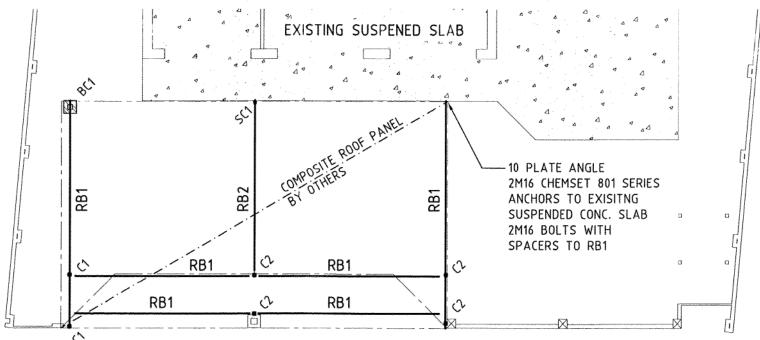

NO ADDITONAL LOAD

ROOF FRAMING & BRACING PLAN SCALE 1:100

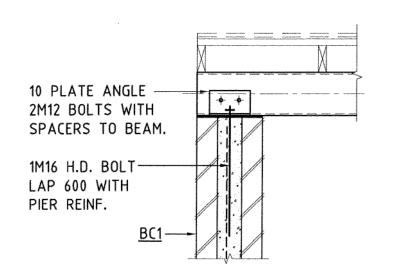

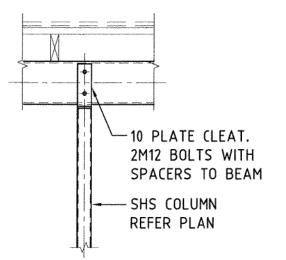

TYPICAL RB1 TO BC1 CONNECTION

TYPICAL RB1 TO SHS COL DETAIL.

LEGEND

- C1 89x6.0 GR.C350 SHS COLUMN H.D.G REFER DETAIL
- 89x6.0 GR.C350 SHS COLUMN H.D.G REFER DETAIL
- 75x4.0 GR.C350 SHS STUB COLUMN REFER DETAIL
- 350SQ BRICKWORK COLUMN REFER DETAIL
- STRATCO 170 PRO-BEAM
- 150x100x4.0 RHS ROOF BEAM



4 kN TOTAL

WIND FORCE RESISTED BY BRICKWORK COLUMN = 3.7kNSHS POSTS = 5kN TOTAL = 8.7kN


TIMBER FRAMING LEGEND

FOR TIMBER FRAMING MEMBERS NOT SHOWN ON THIS DRAWING REFER TO THE NATIONAL TIMBER FRAMING CODE AS1684


TIMBER FRAMING

- 1. TIMBER STRESS GRADES NOMINATED ARE MINIMUM ALLOWABLE VALUES.
- 2. TIMBER SUPPLIER IS TO PROVIDE CERTIFICATION THAT THE TIMBER SUPPLIED IS EQUAL TO OR GREATER THAN THE MINIMUM STRESS GRADE NOMINATED
- 3. GIRDER AND OTHER TRUSSES BY ROOF MANUFACTURER.
- 4. ALL LINTELS TO HAVE FULL WIDTH BEARING ON SUPPORTING PLATES OR BEAMS.
- 5. LOAD BEARING WALL STUDS U.N.O. REFER ARCHITECT'S DRAWINGS OR THE NATIONAL TIMBER FRAMING CODE AS 1684
- 6. EXTRA STUDS AT CONCENTRATED LOADS IN ACCORDANCE
- WITH THE NATIONAL TIMBER FRAMING CODE AS 1684 7. ALL NAILS, BOLTS, NUTS, SCREWS, WASHERS AND TIMBER PLATE FASTENERS TO BE HOT DIPPED GALVANISED.
- 8. FOR FRAMING MEMBERS NOT SHOWN ON THIS DRAWING REFER TO THE NATIONAL TIMBER FRAMING CODE AS 1684

PANEL TO ROOF BEAM IN ACCORDANCE WITH MANUFACTURERS SPECIFICATIONS

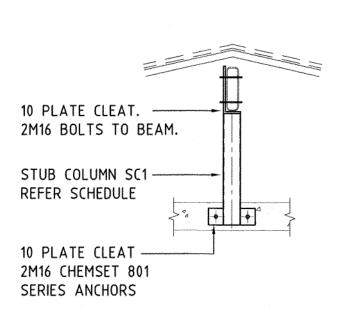

STUB COLUMN SC1 DETAIL SCALE 1:20

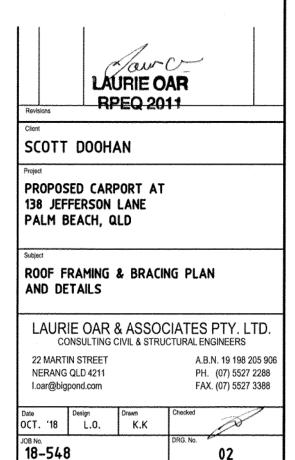

SCALES AS SHOWN AT A3

Development Tribunal Appeal 28-18 Referenced Plans, Page 8 of 8.



Department of Housing and Public Works

Form 15—Compliance certificate for building design or specification Version 4 – July 2017

NOTE: This is to be used for the purposes of section 10 of the *Building Act* 1975 and/or section 46 of the *Building Regulation* 2006.

RESTRICTION: A building certifier (class B) can only give a compliance certificate about whether building work complies with the BCA or a provision of the Queensland Development Code (QDC). A building certifier (Class B) can not give a certificate regarding QDC boundary clearance and site cover provisions.

1.Property description	Street address (include no., street, suburb/locality and postcode)		
This section need only be completed if details of street	138 Jefferson Lane, Palm Beach		
address and property description	Postcode 4221		
are applicable. E.g. in the case of	Lot and plan details (attach list if necessary)		
(standard/generic) pool design/shell			
manufacture and/or patic and carport systems this section may	In which local government area is the land situated?		
not be applicable.	Gold Coast City Council		
The description must identify all land the subject of the application.			
The lot and plan details (e.g.			
SP/RP) are shown on title documents or a rates notice.			
If the plan is not registered by title,			
provide previous lot and plan details.			
2. Description of	Facilities Mall Consider Doof Facility Doof Tis Down		
component/s certified	Footings, Wall Framing, Roof Framing, Roof Tie Down		
Clearly describe the extent of work covered by this certificate, e.g. all			
structural aspects of the steel roof			
beams,			
	.,,,,,,,,,,,,,,,,,,,,,,,,,,,,,,,,,,,,,,		
3. Basis of certification	AS3600, AS1684, AS4100, AS1252, AS1554, AS1170		
Detail the basis for giving the certificate and the extent to which			
tests, specifications, rules,			
standards, codes of practice and other publications, were relied upon.			
4. Reference documentation	Drawing No.18-548/01-02		
Clearly Identify any relevant documentation, e.g. numbered			
structural engineering plans.			

LOCAL GOVERNMENT USE ONLY			

5. Building certifier reference number	Building certifier reference number	
6. Competent person details A competent person for building work, means a person who is assessed by the building certifier for the work as	Name (in full) Laurence James Oar Company name (if applicable)	Contact person
competent to practice in an aspect of the building and specification design,	Laurie Oar & Associates Pty Ltd	Laurie Oar
of the building work because of the individual's skill, experience and qualifications in the aspect. The	Phone no. (business hours) Mobile no.	Fax no.
competent person must also be registered or licensed under a law applying in the State to practice the aspect.	Email address admin@oarengineers.com.au	
If no relevant law requires the individual to be licensed or registered to be able to give the help, the certifier must assess the individual as having appropriate experience, qualifications or skills to be able to give the help.	Postal address 22 Martin Street, Nerang QLD Licence or registration number (if applicable)	Postcode 4211
If the chief executive issues any guidelines for assessing a competent person, the building certifier must use the guidelines when assessing the person.	RPEQ 2011	
7. Signature of competent person This certificate must be signed by the individual assessed by the building certifier as competent.	Signature Caum Co.	Date 6th November, 2018

The Building Act 1975 is administered by the Department of Housing and Public Works